

# BONNAVILLA - AMES

1543 EA UNIT X 2 = 3086 SQ. FT.



DEALER


BONNAVILLA  
111 GRANT STREET  
P.O. BOX 127  
AURORA, NE 68818  
402.694.5250

CUSTOMER

AMES

## SHEET LIST

NO.	SHEET NAME
00	COVER SHEET
01A	1ST FLOOR PLAN
08A	ELECTRICAL PLAN 1ST FLR
08B	ELECTRICAL PLAN 2ND FLR
09	EXTERIOR ELEVATIONS
14	FOUNDATION PLAN
15A	CABINET DETAILS - UNIT 1
15B	CABINET DETAILS - UNIT 2
16	BUILDING SECTION

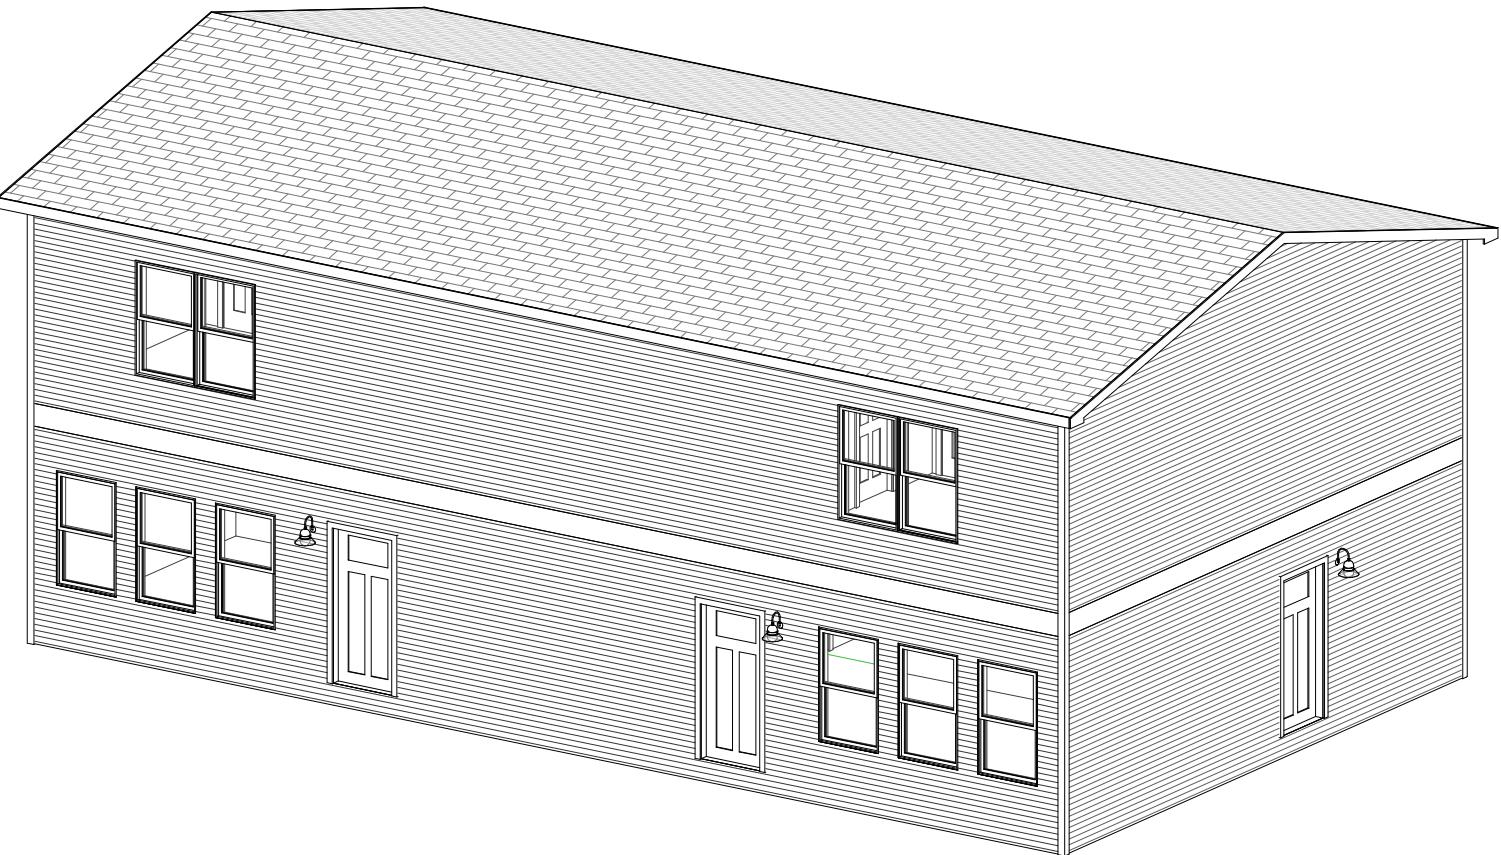

DESCRIPTION	REV.	DATE	DRW.	CES	BANKPACK	PRELIMINARY ISSUE	DINRY
CODE: 2018 IRC							
QUOTE NO.:							
PID:							
CODE: 2018 IRC							
FLOOR LOAD:	40	PSF					
ROOF LOAD:	40	PSF					
ZONE:	A	04/30/21	CES				
WIND:							
ZONE:	115	VULT MPH	A	04/29/20	CES		
REF.:							



BONNAVILLA	SITE ADDRESS	GRAND ISLAND, NE	DRAWING TITLE	COVER SHEET
A DIVISION OF CHIEF INDUSTRIES, INC. 111 GRANT STREET, AURORA, NEBRASKA 68818				


DRW. BY:	CES
DATE:	02/05/20

DWG No.	00
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# AMES

29'-8" x 52'-0"



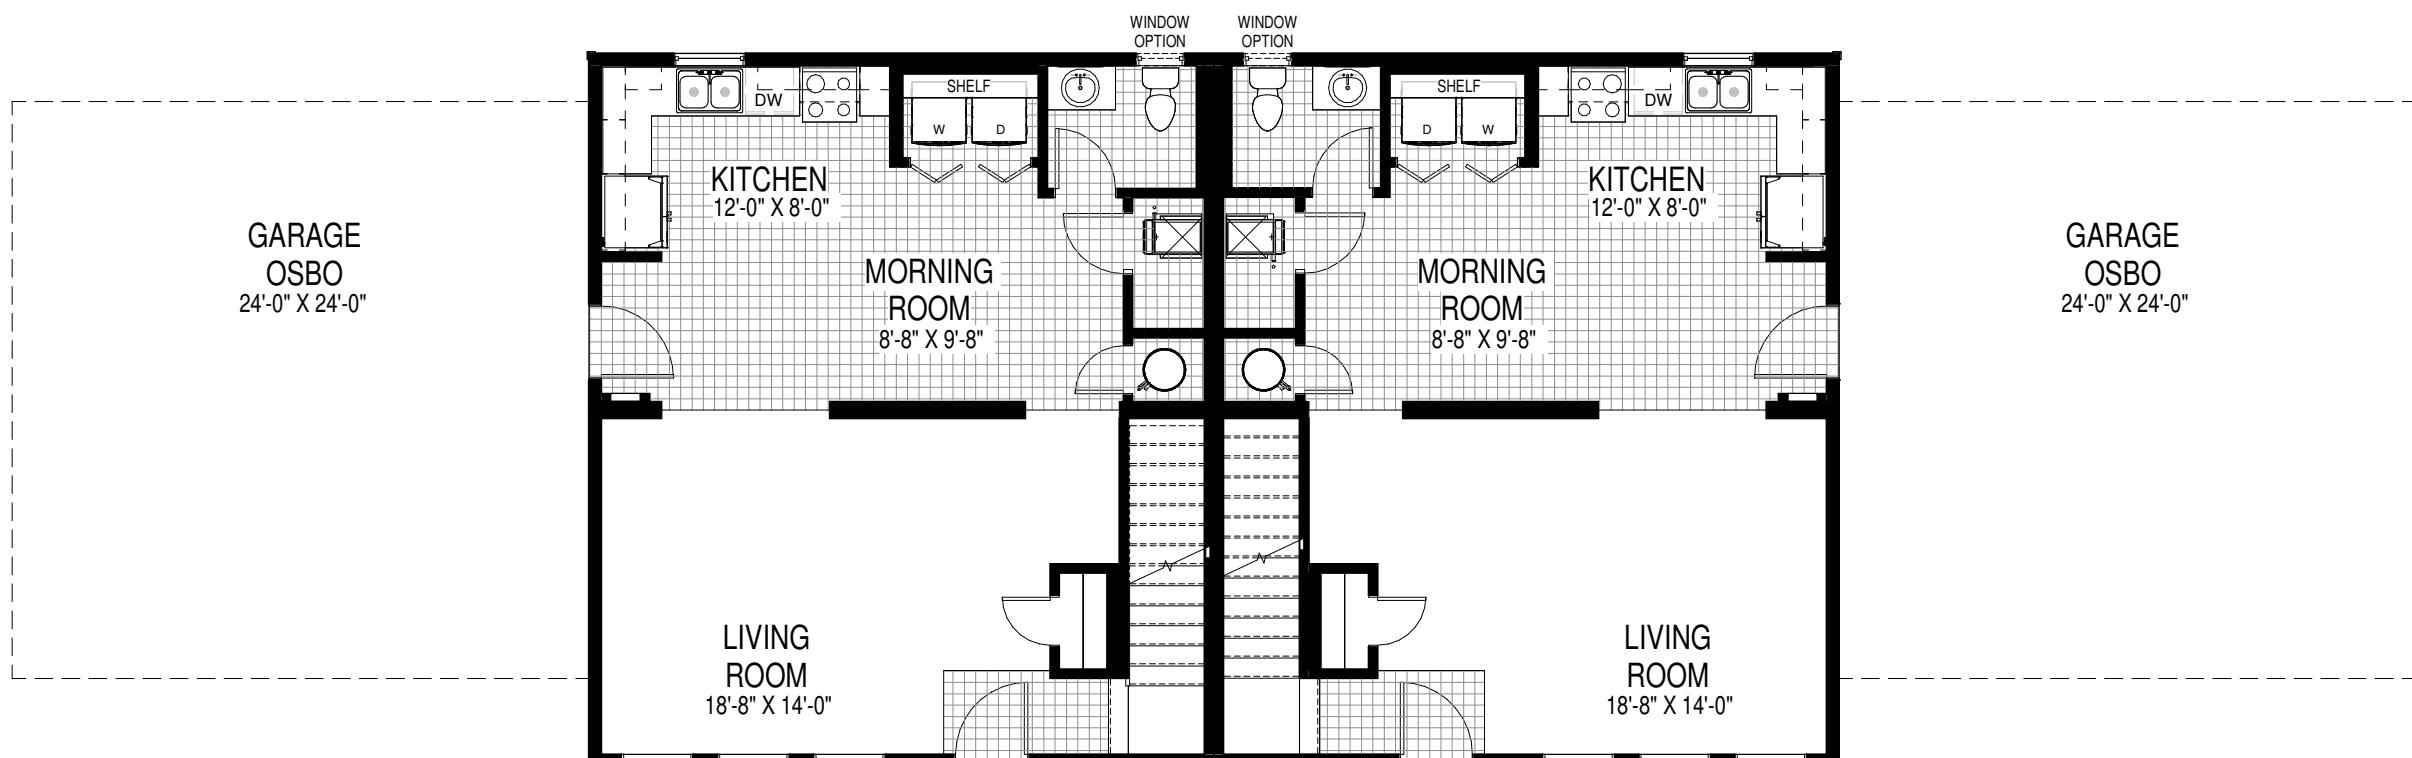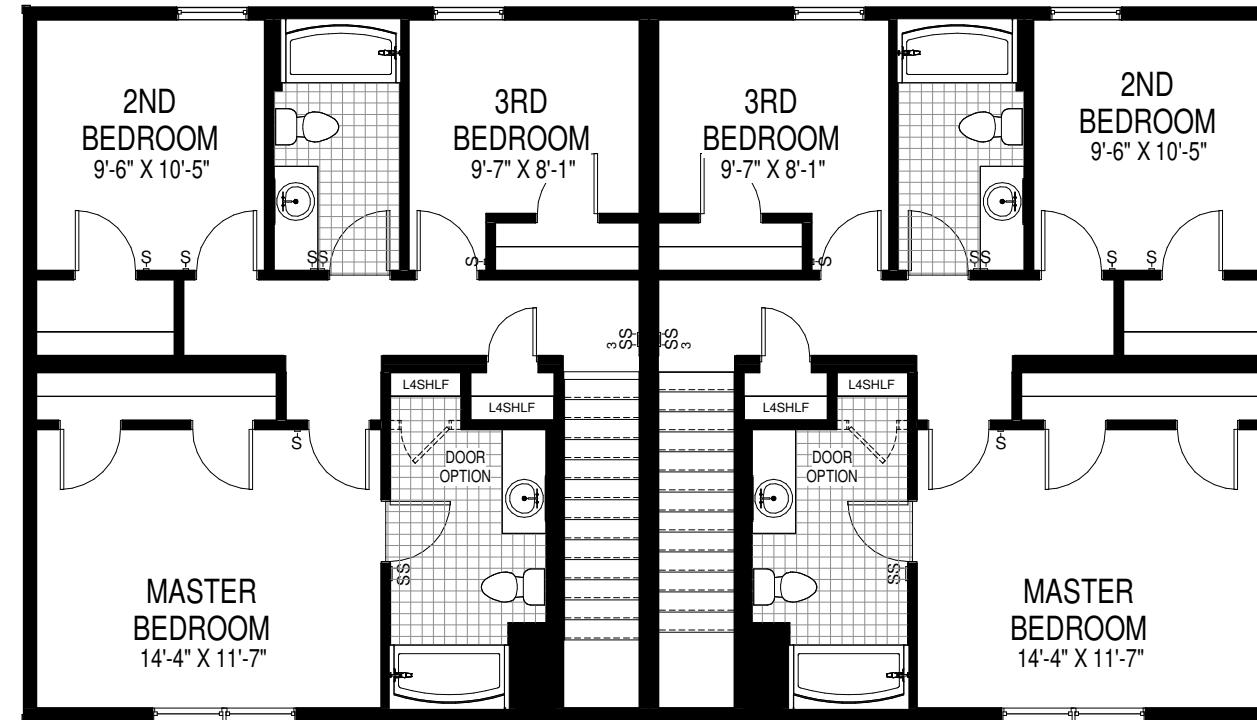

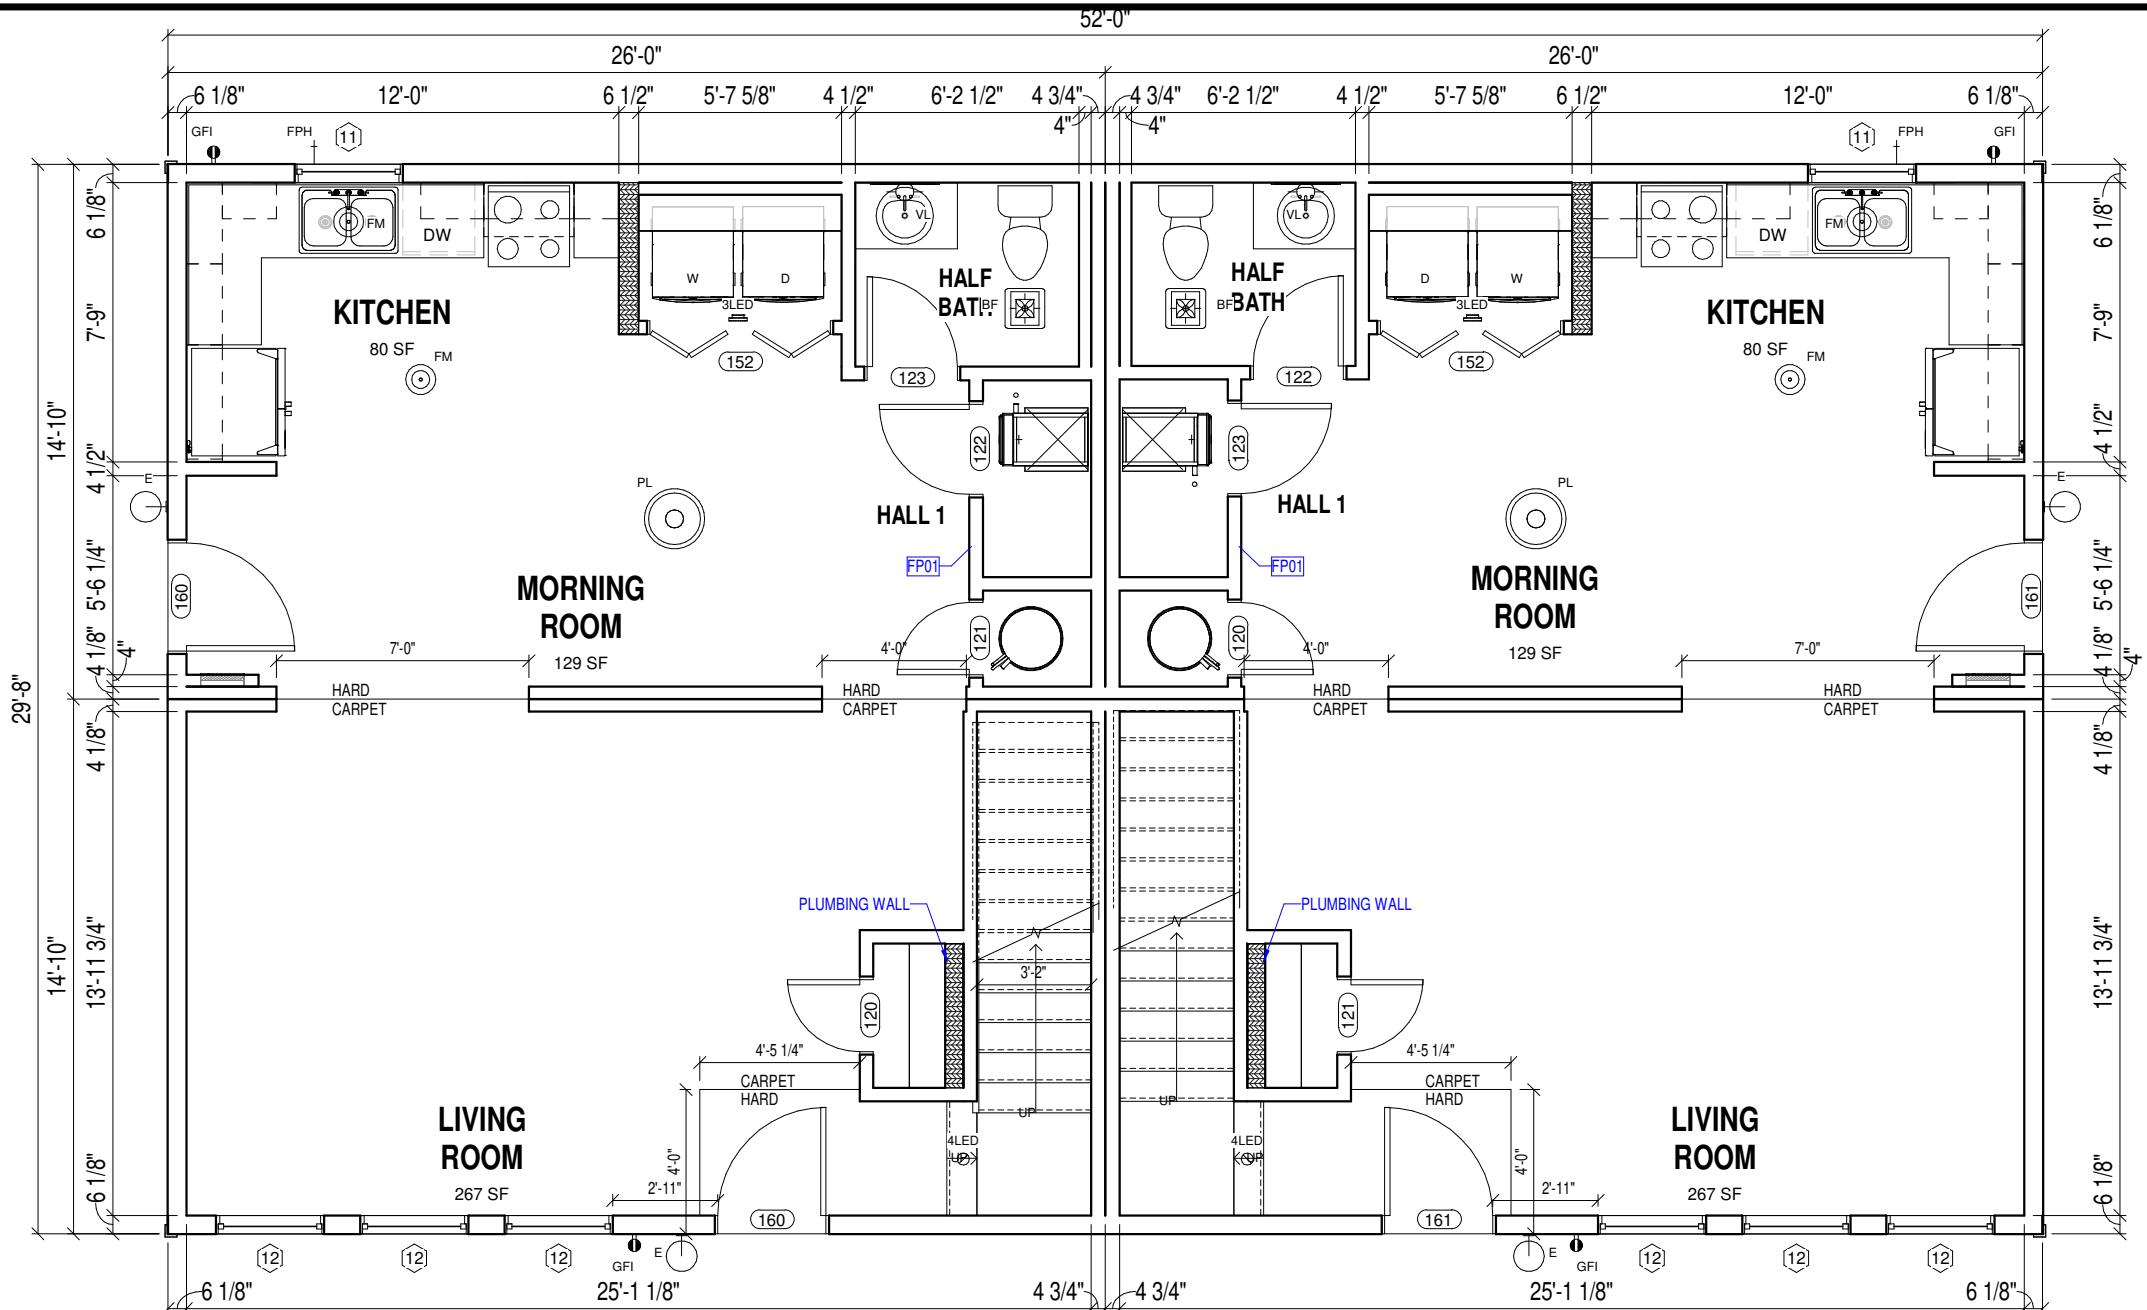EXTERIOR DOOR SCHEDULE				
ID #	QTY	DESCRIPTION	SWING	JAMB
160	2	36"x80" 3-PANEL FIBERGLASS	RIGHT	6 1/8"
161	2	36"x80" 3-PANEL FIBERGLASS	LEFT	6 1/8"

INTERIOR DOOR SCHEDULE				
ID #	QTY	DESCRIPTION	SWING	JAMB
120	1	24"x80"	RIGHT	3"
120	2	24"x80"	RIGHT	4 1/2"
121	1	24"x80"	LEFT	3"
121	2	24"x80"	LEFT	4 1/2"
122	11	30"x80"	RIGHT	4 1/2"
123	11	30"x80"	LEFT	4 1/2"
152	2	60" BI-FOLD DOORS		4 1/2"

WINDOW SCHEDULE			
ID #	QTY	DESCRIPTION	COMMENTS
11	2	36"x36" S/H	
12	10	36"x60" S/H EGRESS	
15	2	DOUBLE 36"x60" S/H EGRESS	W/ LIMITERS

LIGHTING FIXTURE SCHEDULE			
ID #	QTY	DESCRIPTION	COMMENTS
3LED	5	3" LED SURFACE MOUNT CAN LIGHT (WALL)	
4LED	4	4" LED CAN LIGHT (WATERPROOF)	
AA	2	ATTIC ACCESS	
BF	6	BATHFAN/LIGHT COMBO	
E	4	EXTERIOR CLEAR GLASS LIGHT	
FM	14	FLUSH MOUNT LIGHT	
PL	2	PENDANT LIGHT	
VL	6	VANITY LIGHT	

ROOM SQ FT SCHEDULE	
Name	Area
1BCLO	20.00 SF
1BCLO	20.00 SF
2BCLO	18.21 SF
2BCLO	18.21 SF
2ND BEDROOM	99.16 SF
2ND BEDROOM	99.16 SF
3BCLO	12.00 SF
3BCLO	12.00 SF
3RD BEDROOM	84.99 SF
3RD BEDROOM	84.99 SF
ENTRY	23.20 SF
ENTRY	23.20 SF
MASTER BATH	76.86 SF
MASTER BATH	76.86 SF
MASTER BEDROOM	166.45 SF
MASTER BEDROOM	166.45 SF
MORNING ROOM	129.18 SF
MORNING ROOM	129.10 SF
G CLO	8.00 SF
G CLO	8.00 SF
HALF BATH	31.69 SF
HALF BATH	31.56 SF
HALL 1	31.32 SF
HALL 1	31.40 SF

ROOM SQ FT SCHEDULE	
Name	Area
HALL 2	71.85 SF
HALL 2	71.85 SF
KITCHEN	79.90 SF
KITCHEN	79.81 SF
LIN CLO	6.99 SF
LIN CLO	6.99 SF
LIVING ROOM	266.79 SF
LIVING ROOM	266.79 SF
MAIN BATH	53.81 SF
MAIN BATH	53.81 SF
MASTER BATH	23.20 SF
MASTER BATH	23.20 SF
MASTER BEDROOM	166.45 SF
MASTER BEDROOM	166.45 SF
FURN	16.44 SF
FURN	16.38 SF
G CLO	8.00 SF
G CLO	8.00 SF
HALF BATH	31.69 SF
HALF BATH	31.56 SF
HALL 1	31.32 SF
HALL 1	31.40 SF

### LEGEND

01	WALL FRAMING ELEVATION
FP01	KEYNOTE
XXXXXX	6" WALL THICKNESS
	HALF WALL
— — — —	ISLAND WALL (HEIGHT VARIES)

### GENERAL NOTES

1. ALL CLOSETS TO BE 2'-0" DEEP U.N.O.
2. ALL SHELVING TO BE SINGLE SHELF W/ROD U.N.O.
3. ALL EXTERIOR WALLS TO BE 2x6 CONSTRUCTION U.N.O.
4. ALL DIMENSION ARE TO EDGE OF GYP BOARD OR OSB U.N.O.


### ABBREVIATIONS

DB	DRAWER BANK
DW	DISHWASHER
L	LINEN
P	PANTRY
PP	POTS & PANS PULLOUT
UNO	UNLESS OTHERWISE NOTED
W	WASHER
D	DRYER
DOV	DOUBLE OVEN CABINET
MWV	MICROWAVE & OVEN CABINET
OV	OVEN CABINET
MW	MICROWAVE OR MICROWAVE CABINET

### KEYNOTES

FP01 RETURN AIR GRILLE  
(GRILLE PLACE VERTICAL)

CODE: 2018 IRC FLOOR: 40 LOAD: 40 ROOF: 40 ZONE: WIND: MPH: 115 WIND: MPH: 115 VULT: 40 DATE: 04/30/21 DEALER: BONNAVILLA	QUOTE NO.: PID: BONNAVILLA	CUSTOMER AMES		
		SITE ADDRESS: GRAND ISLAND, NE	DRAWING TITLE: 1ST FLOOR PLAN	
BONNAVILLA A DIVISION OF CIEF INDUSTRIES, INC. 111 GRANT STREET, AURORA, NEBRASKA 68818		DRAWING TITLE: 1ST FLOOR PLAN		
DRN. BY: CES DATE: 02/05/20 DWG No. 01A				

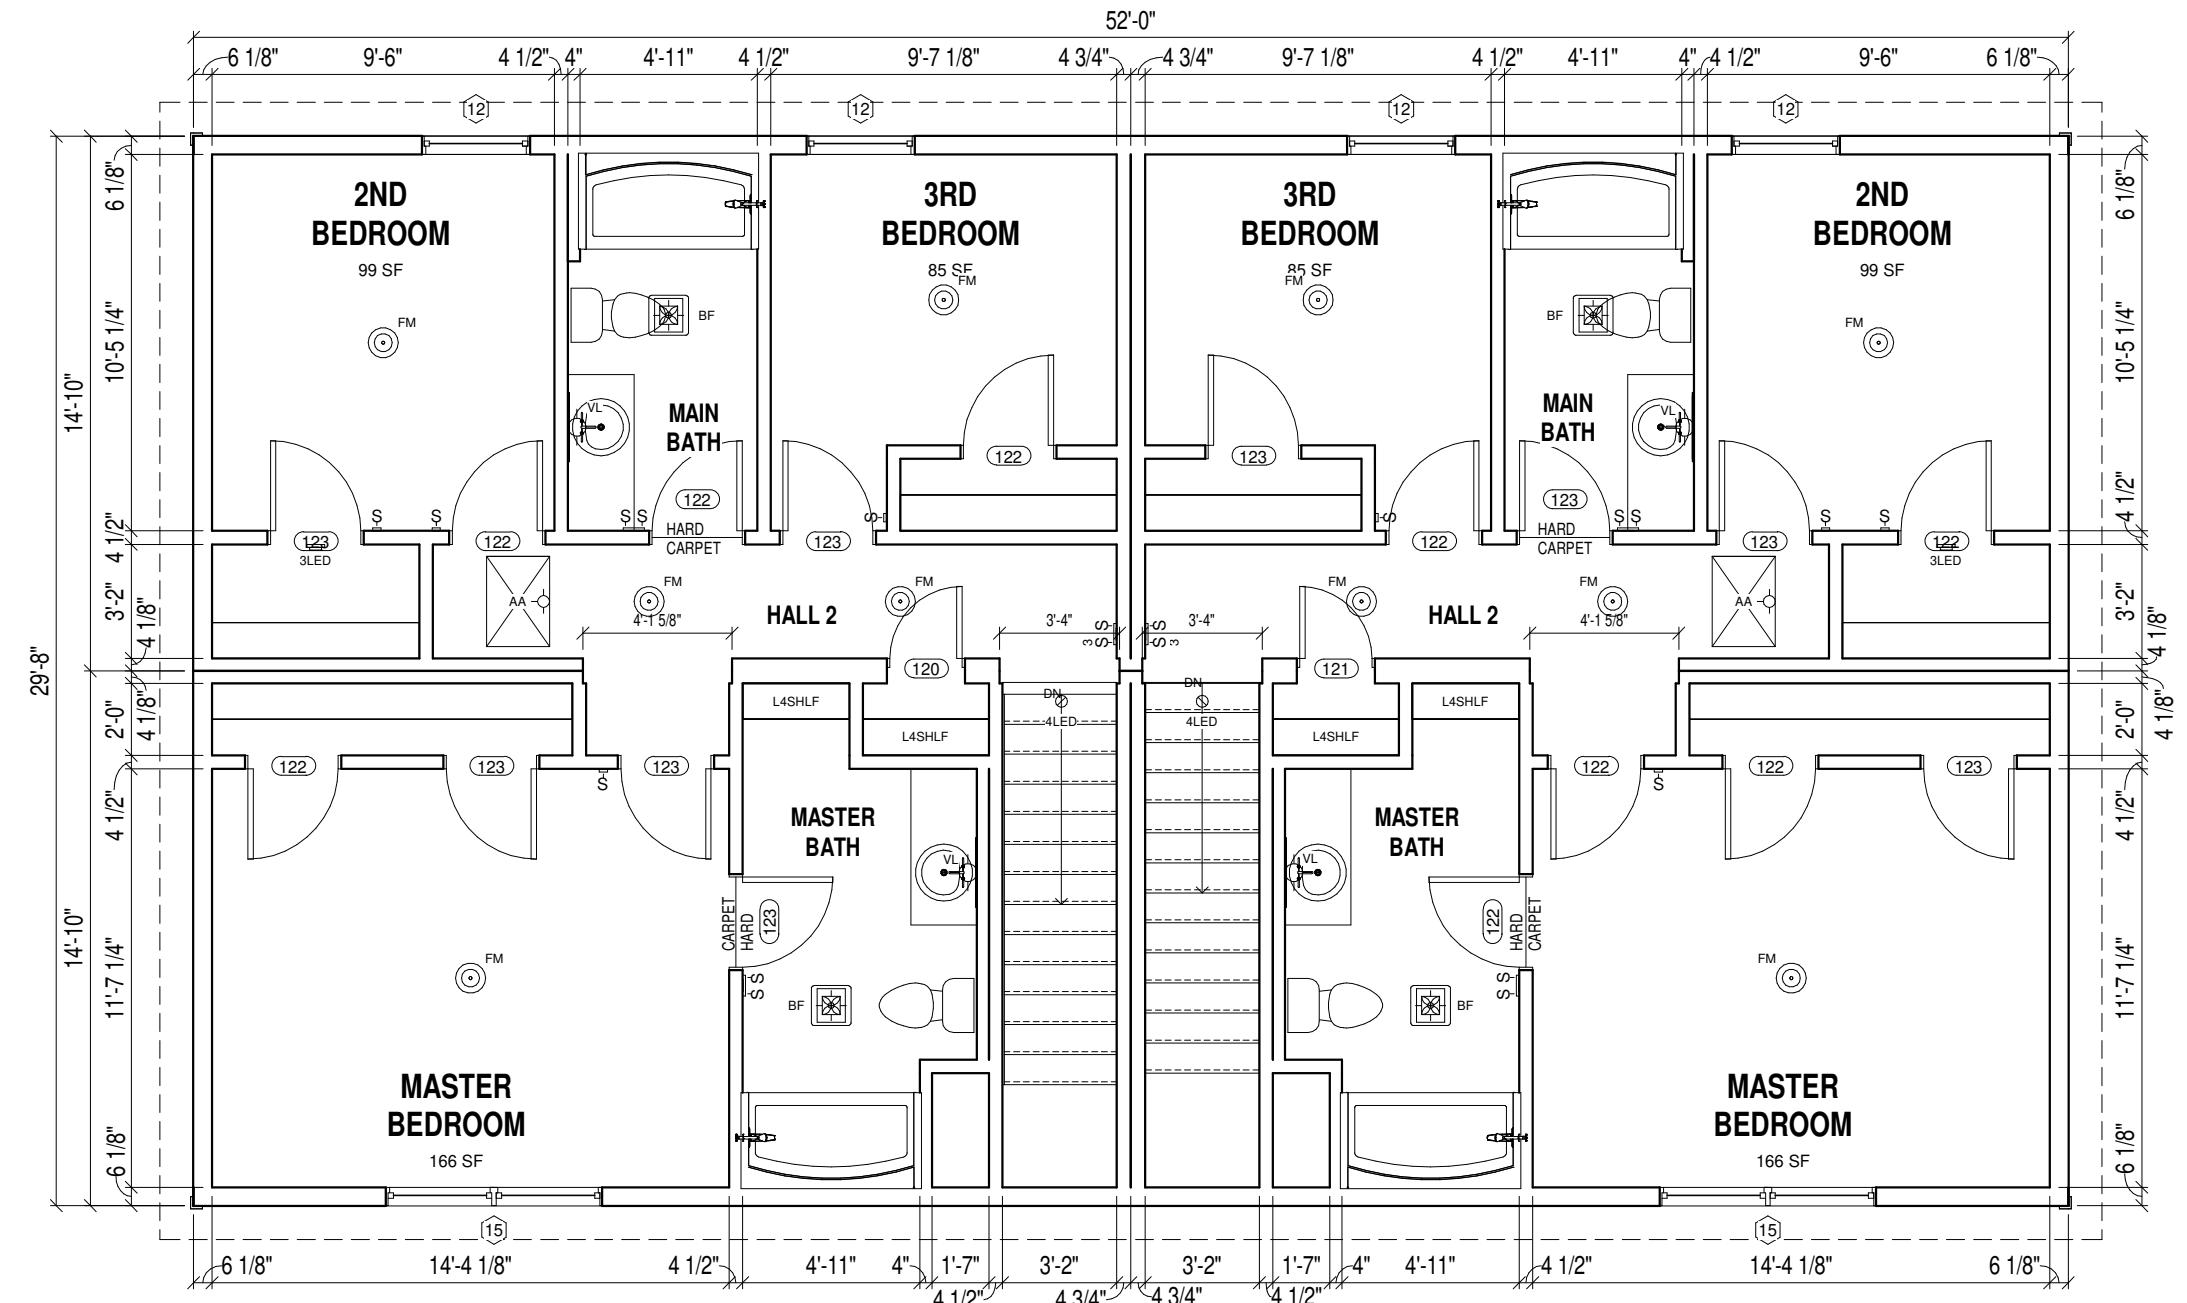


1 2ND FLOOR PLAN  
01B SCALE (22x34): 3/8" = 1'-0"  
SCALE (11x17): 3/16" = 1'-0"

3 SCALE (22x34): 3/8" = 1'-0"  
SCALE (11x17): 3/16" = 1'-0"

SCALE (22x34): 3/8" = 1'-0"

SCALE (22x34):  $3/8'' = 1'-0''$

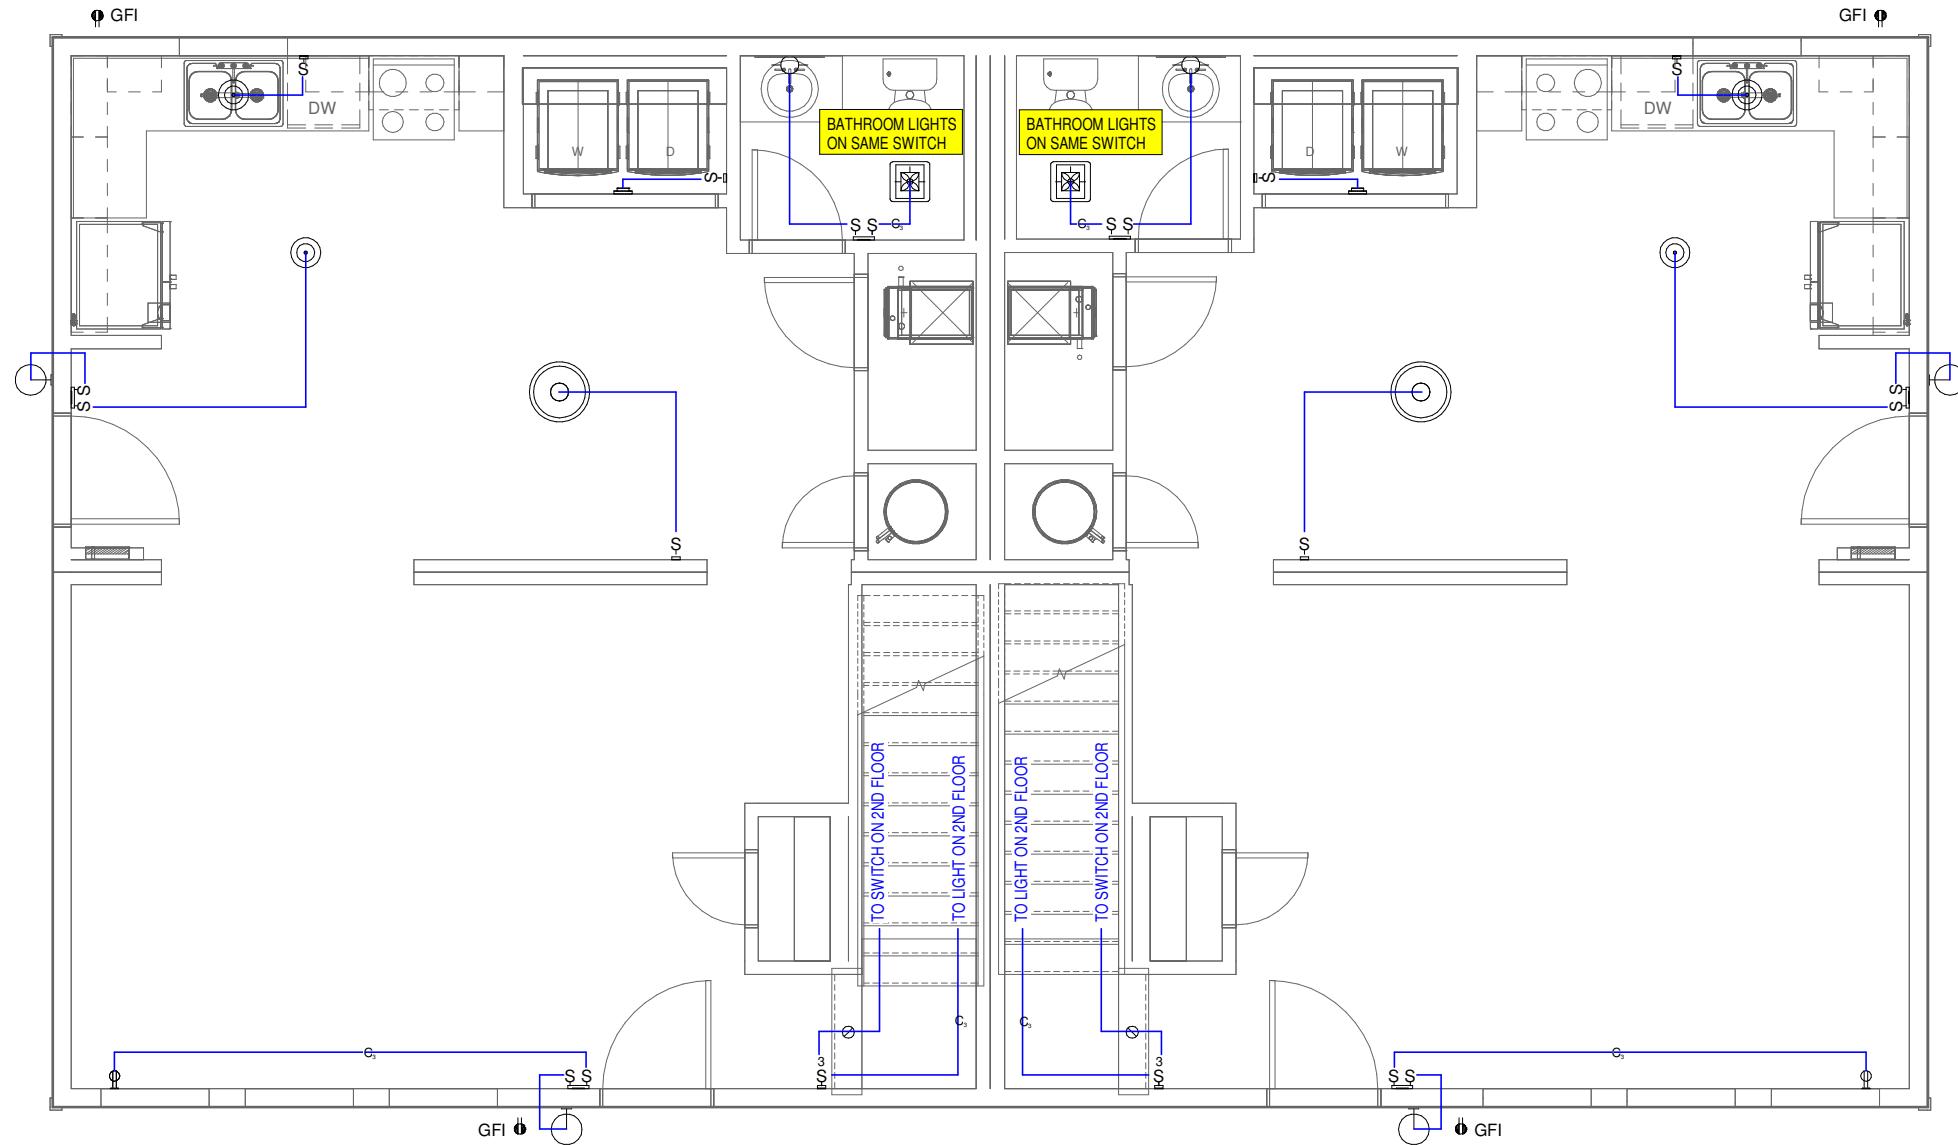


1 ELECTRICAL PLAN 1ST FLR

**ELECTRICAL LEGEND**

● GFI	INTERIOR DUPLEX RECEPT	SWITCH
● GFI	INTERIOR SINGLE RECEPT	3-WAY SWITCH
● GFI	INTERIOR GROUND FAULT DUPLEX RECEPT	RHEOSTAT
● GFI	EXTERIOR GROUND FAULT DUPLEX RECEPT	3-WAY RHEOSTAT
● GFI	FLOOR DUPLEX RECEPT	TIMER SWITCH
● GFI	SOFFIT GROUND FAULT DUPLEX RECEPT	PANEL BOX
● GFI	ELECTRIC RANGE RECEPT	▽ JACK SYMBOL FOR TV, PH, CA5, WPH
● GFI	DRYER RECEPT	TV CABLE JACK
● GFI	220 OUTLET	PH PHONE JACK
● GFI	THERMOSTAT	CA5 DATA JACK
● GFI	SMOKE DETECTOR	WPH WALL PHONE JACK
● GFI	SMOKE-CO DETECTOR	

**ELECTRICAL NOTES**

1. ALL 125-VOLT, 15 & 20 AMP RECEPTACLES SHALL BE LISTED TAMPER-RESISTANT RECEPTACLES.
2. OUTDOOR RECEPTACLES EQUIPPED WITH IN USE WEATHER PROOF COVERS & "EXTRA DUTY" TYPE.
3. ALL RECEPTACLE AND SWITCH LOCATIONS ARE TYPICAL HEIGHT U.N.O. NO AMP CONNECTORS - ALL CONNECTIONS MUST BE MADE IN BOX. (NORTH DAKOTA ONLY)
4. LIGHTS WITH DIMENSIONS WILL BE LOCATED IN DROPPED CEILINGS.
5. EXTERIOR LIGHTS ARE TO BE LISTED FOR WET LOCATIONS.

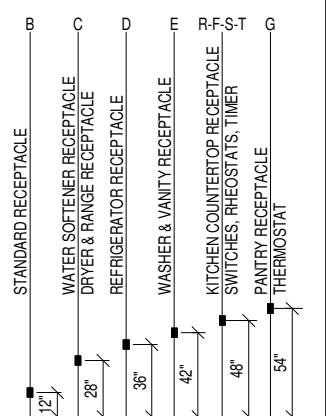

**BONNAVILLA**  
A DIVISION OF CIEF INDUSTRIES, INC.  
111 GRANT STREET, AURORA, NEBRASKA 68818

DESCRIPTION	PRELIMINARY ISSUE	DRAWN BY	CES	DATE	04/29/20	DESIGNER	04/30/21	CES	BANKPACK

CUSTOMER AMES  
DEALER  
BONNAVILLA


QUOTE NO.:

PID:

CODE: 2018IRC	FLOOR LOAD:	40 PSF	ROOF LOAD:	40 PSF	WIND ZONE:	WIND MPH	WIND ZONE: 115 VULT MPH	WIND ZONE: 115 VULT MPH	WIND ZONE: 115 VULT MPH

ITEM	DESCRIPTION	QTY	UNIT	ITEM	DESCRIPTION	QTY	UNIT

08A  
DWG No.

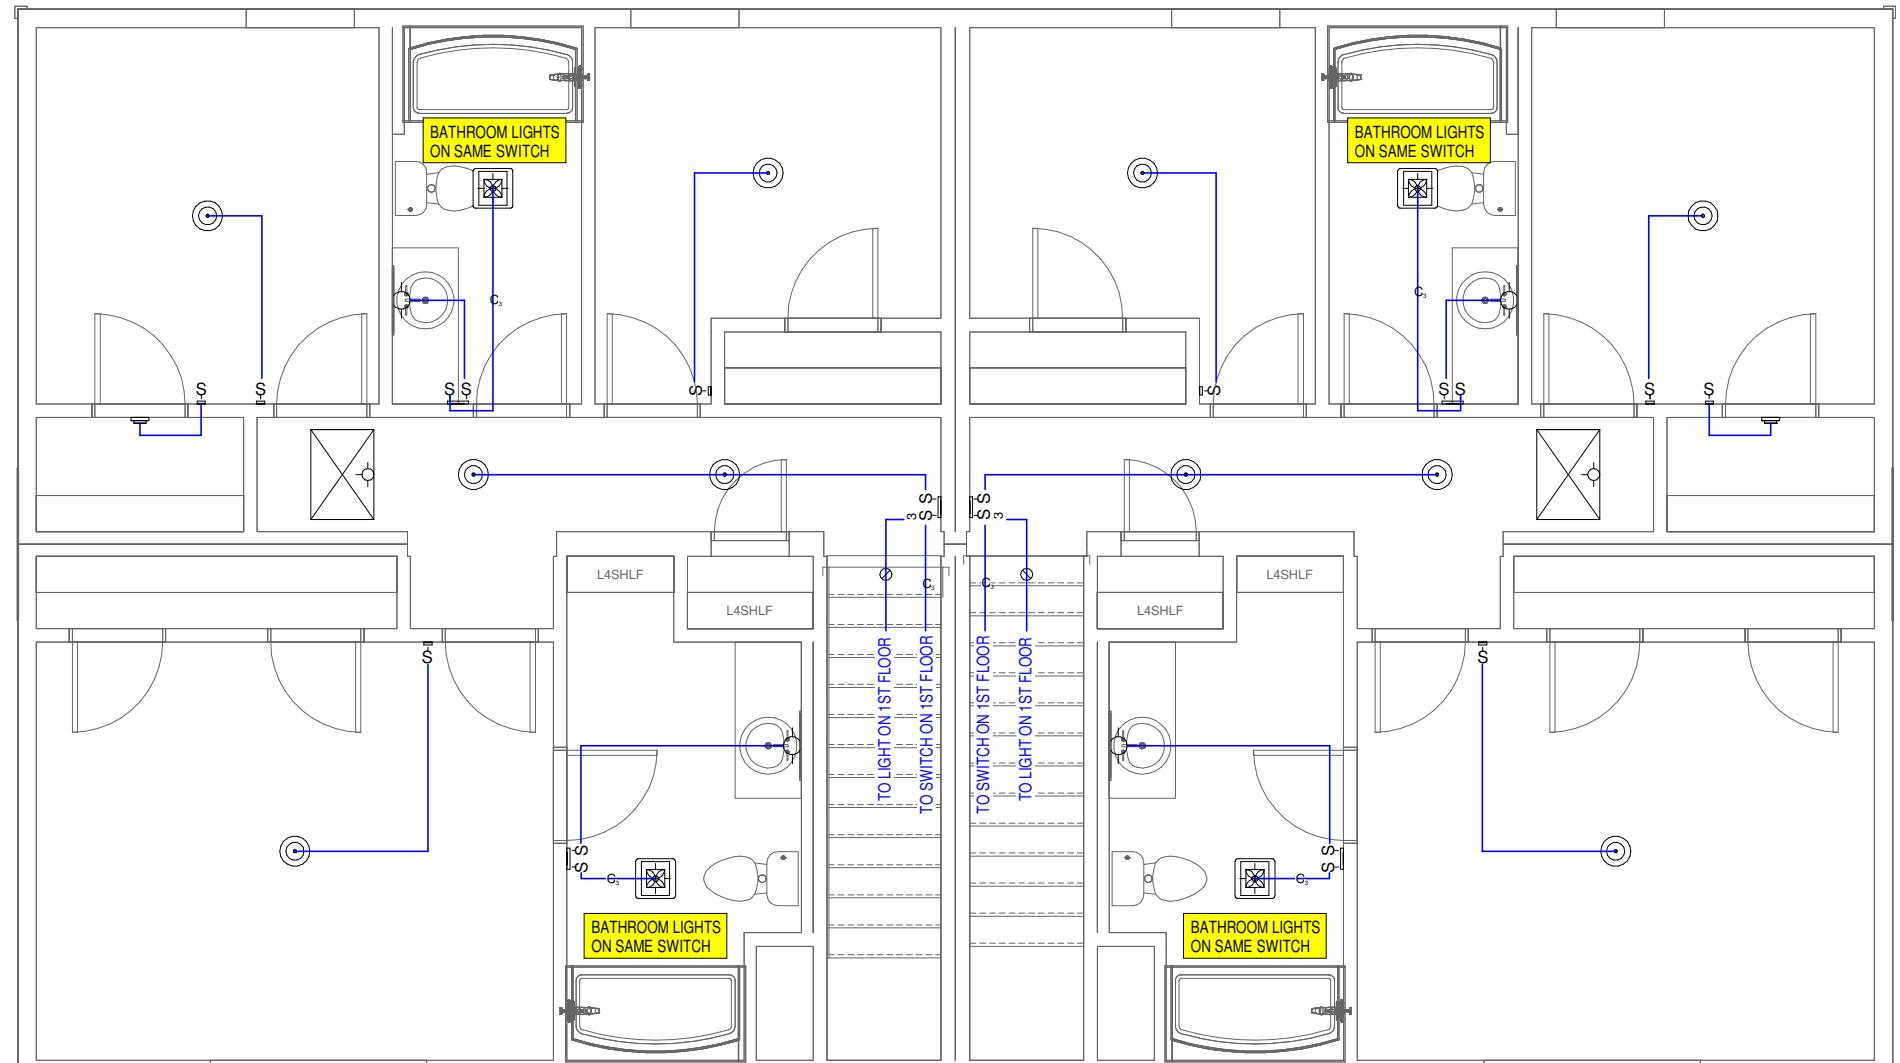


1 ELECTRICAL PLAN 2ND FLR

## ELECTRICAL LEGEND

	INTERIOR DUPLEX RECEPT		SWITCH
	INTERIOR SINGLE RECEPT		3-WAY SWITCH
	INTERIOR GROUND FAULT DUPLEX RECEPT		RHEOSTAT
	EXTERIOR GROUND FAULT DUPLEX RECEPT		3-WAY RHEOSTAT
	EXTERIOR DUPLEX RECEPT		TIMER SWITCH
	FLOOR DUPLEX RECEPT		PANEL BOX
	SOFFIT GROUND FAULT DUPLEX RECEPT		JACK SYMBOL FOR TV,
	ELECTRIC RANGE RECEPT		CABLE JACK
	DRYER RECEPT		PHONE JACK
	220 OUTLET		DATA JACK
	THERMOSTAT		WALL PHONE JACK
	SMOKE DETECTOR		
	SMOKE-CO DETECTOR		

## ELECTRICAL NOTES

- ALL 125-VOLT, 15 & 20 AMP RECEPTACLES SHALL BE LISTED TAMPER-RESISTANT RECEPTACLES.
- OUTDOOR RECEPTACLES EQUIPPED WITH IN USE WEATHER PROOF COVERS & "EXTRA DUTY" TYPE.
- ALL RECEPTACLE AND SWITCH LOCATIONS ARE TYPICAL HEIGHT U.N.O.
- NO AMP CONNECTORS - ALL CONNECTIONS MUST BE MADE IN BOX.  
(NORTH DAKOTA ONLY)
- LIGHTS WITH DIMENSIONS WILL BE LOCATED IN DROPPED CEILINGS.
- EXTERIOR LIGHTS ARE TO BE LISTED FOR WET LOCATIONS

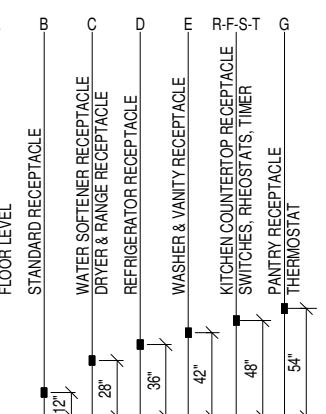

**BONNAVILLA**


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DATE: 0  
DWG No.

08


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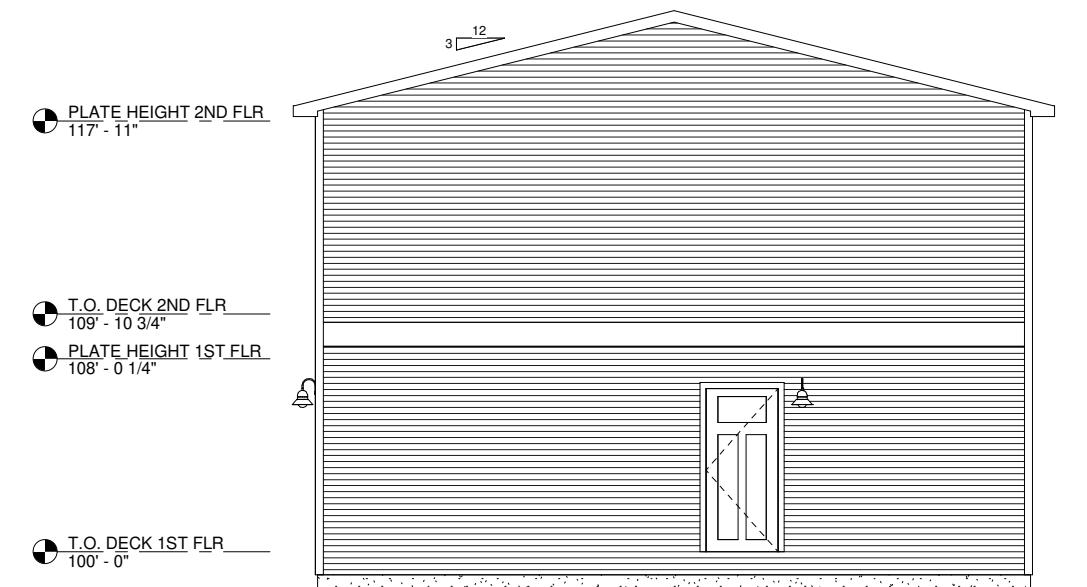
1 FRONT ELEVATION




2 REAR ELEVATION

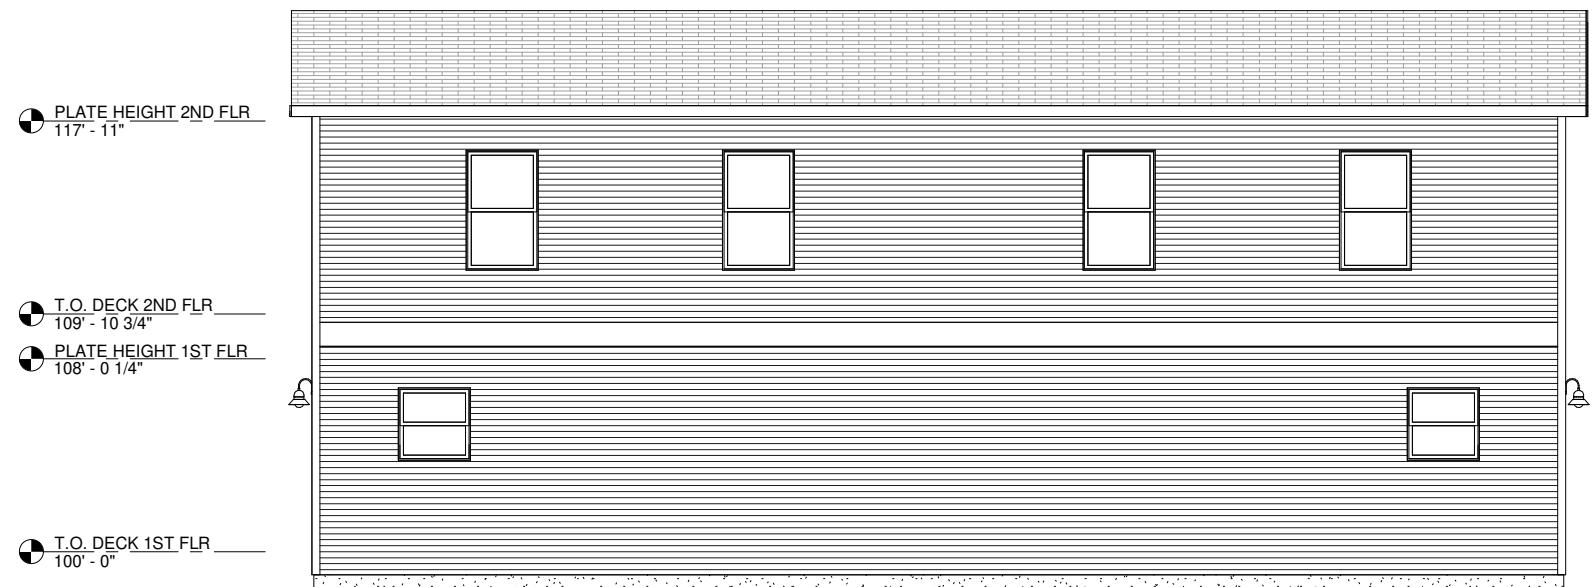

### 3 LEFT ELEVATION

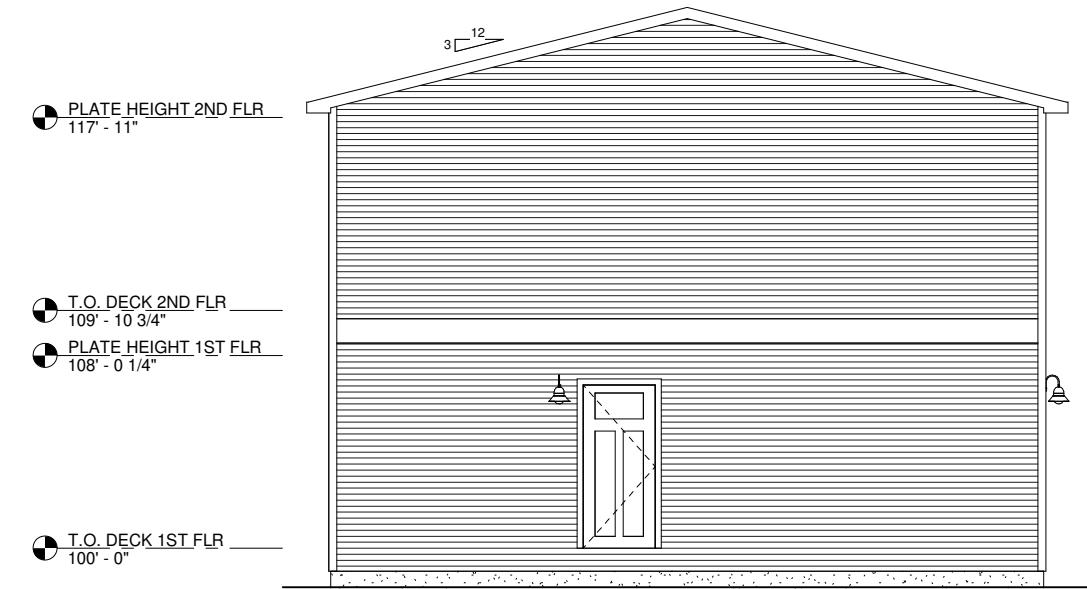


## 4 RIGHT ELEVATION

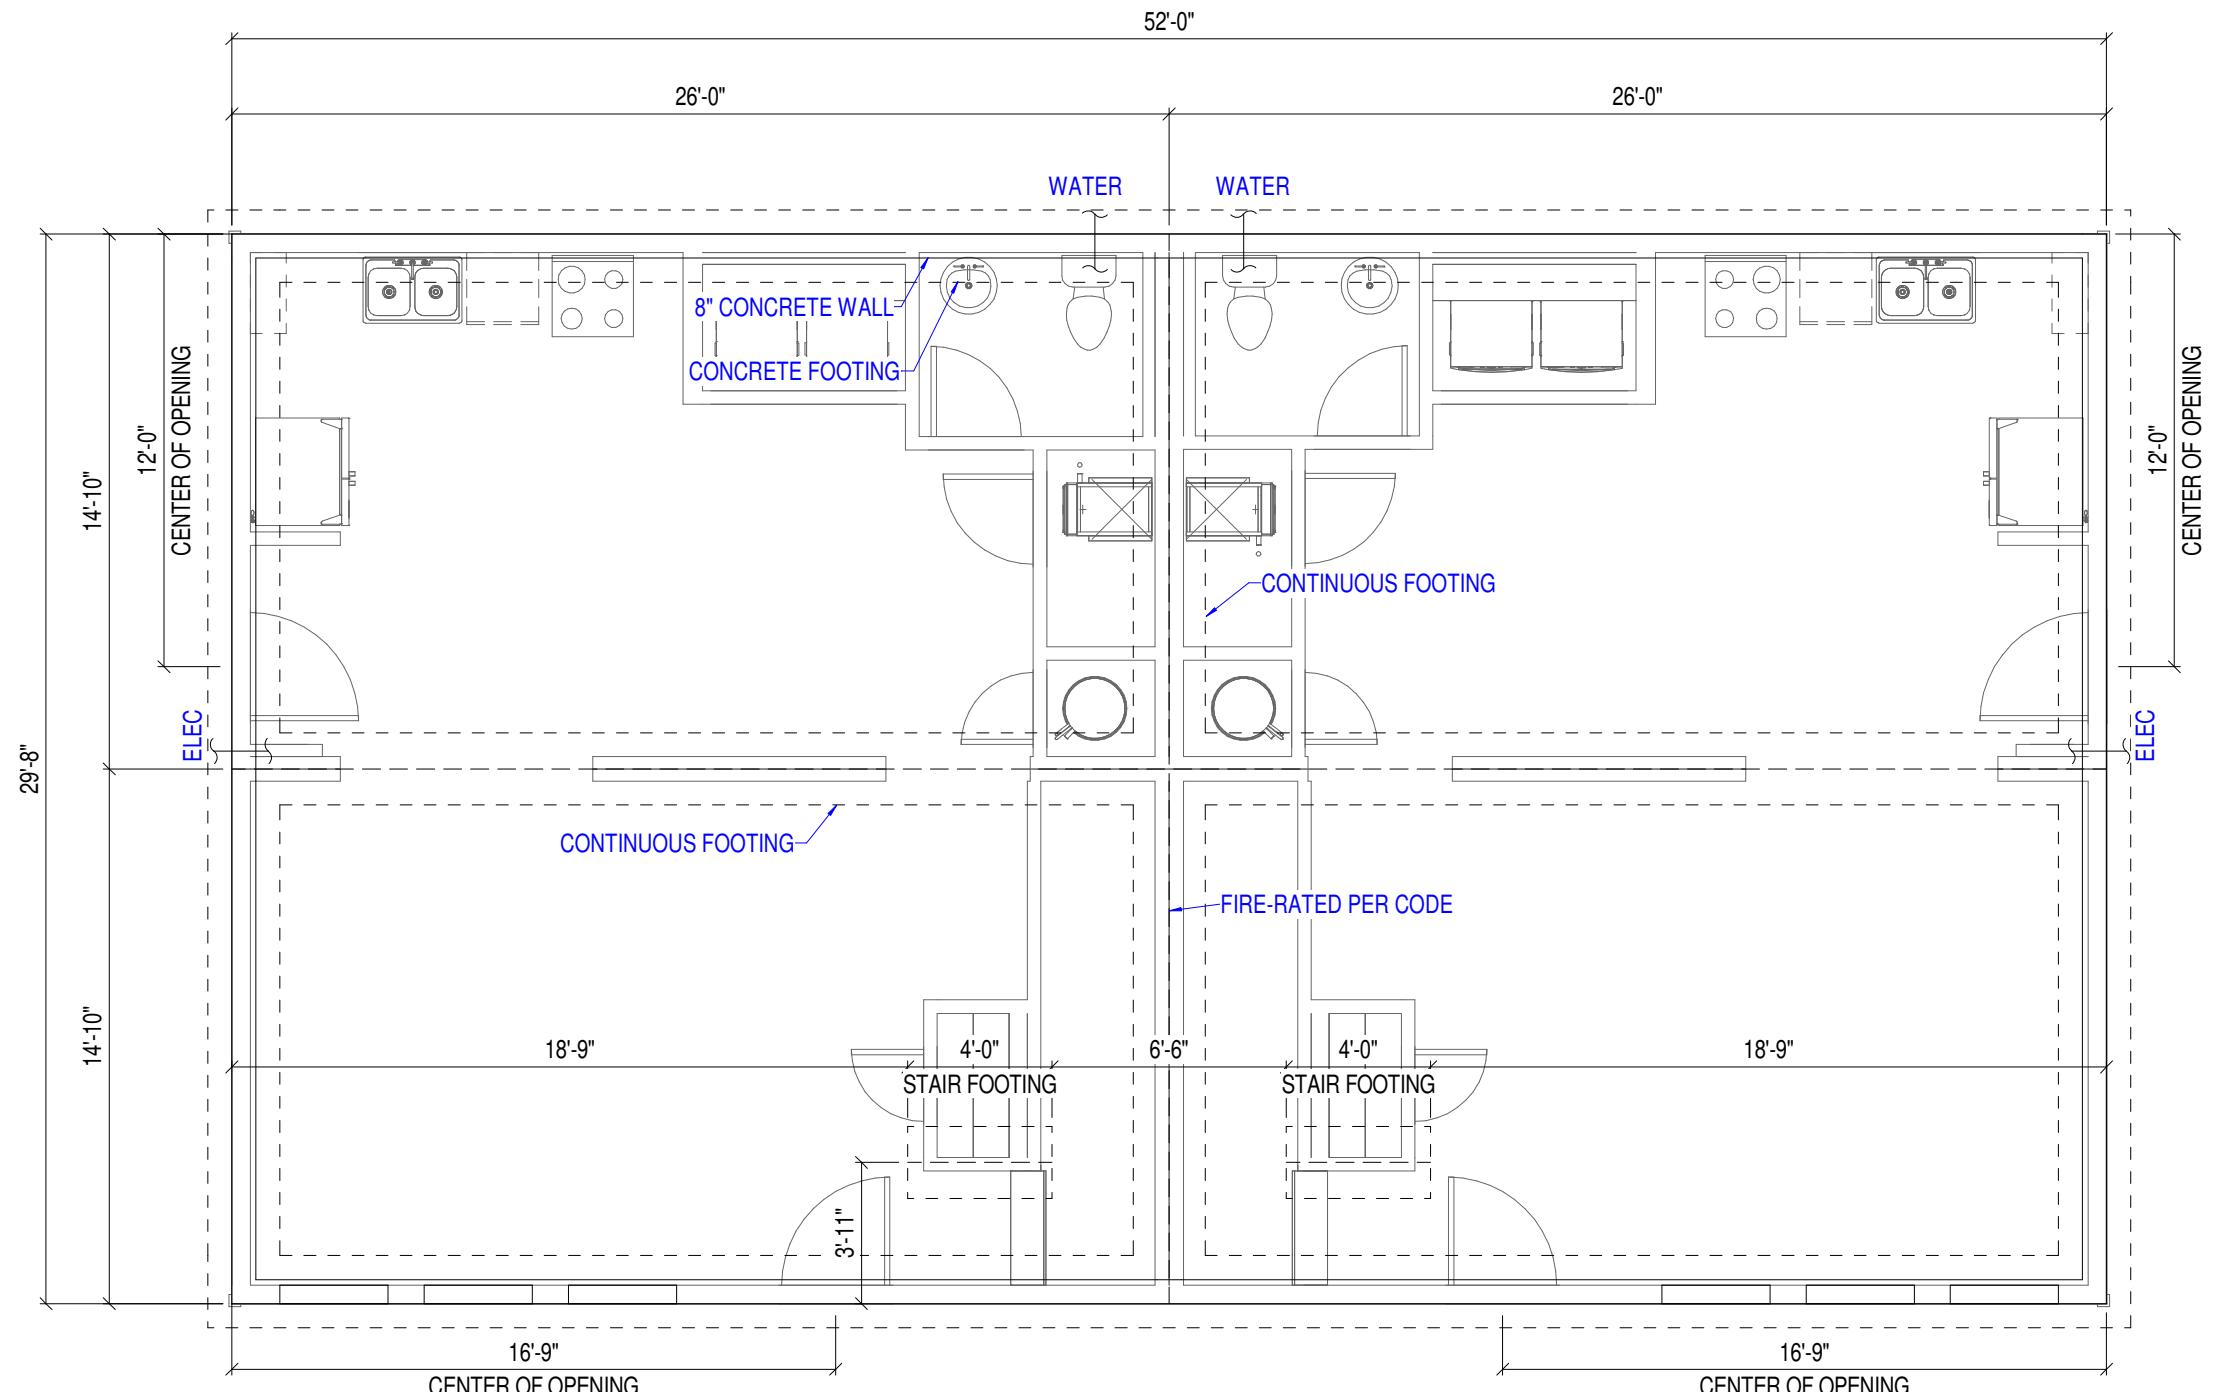

## 1 FOUNDATION PLAN

## FOUNDATION NOTES:


1. FOUNDATION, FOOTINGS, AND/OR PIERS DESIGNED TO THE FOLLOWING LOADING CRITERIA:
  - a. FLOOR 40 PSF LL, 15 PSF DL
  - b. WALL 5 PLF DL
  - c. ROOF 45 PSF LL, 15 PSF DL
2. FOR CRAWLSPACE APPLICATION, THE MINIMUM NET AREA OF VENTILATION OPENINGS FOR UNDER-FLOOR VENTILATION SHALL MEET THE MINIMUM REQUIREMENTS OF THE APPLICABLE BUILDING CODES (OR LOCAL REQUIREMENTS IF MORE STRINGENT).
3. FOUNDATION ACCESS SHALL BE DETERMINED, LOCATED, VERIFIED, AND INSTALLED IN FIELD, BY OTHERS TO THE APPLICABLE BUILDING CODES.
4. THE RIM JOIST ALONG THE MARRIAGE LINE CONSISTS OF 1-1/2" x 11-7/8" LAMINATED BEAMS. PROVIDE SUPPORTS PIERS ALONG THE MARRIAGE LINE 2-3/4" SHORTER THAN PERIMETER SUPPORTS. (NOT APPLICABLE WITH TRUSS FLOOR SYSTEMS)
5. THE HOME SHALL BE GROUNDED AS DEFINED IN ARTICLE 250, SECTION III, OF THE 2017 NATIONAL ELECTRICAL CODE AS PART OF THOSE REQUIREMENTS, A FOOTING/FOUNDATION REBAR SHALL BE LEFT EXPOSED SO A CONNECTION CAN BE MADE WITH THE BUILDING STRUCTURE, AS DEFINED IN NEC ARTICLE 250, SECTION III, PART 50.
6. BONNAVILLA HOMES SHALL NOT BE IN ANY WAY RESPONSIBLE FOR THE QUALITY OF THE QUANTITY OF MATERIALS USED (OR NOT USED)
7. IN THE FABRICATION AND FINAL CONSTRUCTION OF THIS FOUNDATION, BONNAVILLA HOMES SHALL NOT BE RESPONSIBLE FOR ANY STANDARDS OF WORKMANSHIP.
8. WHERE REPRESENTATIVES AND/OR DEALERS OF BONNAVILLA HOMES ARE ACTING AS INDEPENDENT CONTRACTORS, THEY DO SO AS THEIR OWN REPRESENTATIVE.
9. IT IS THE RESPONSIBILITY OF THE HOMEOWNER AND/OR FOUNDATION CONTRACTOR TO MEET ALL ELECTRICAL, MECHANICAL, ENERGY, AND BUILDING CODES WHICH MAY APPLY TO THIS FOUNDATION PLAN.
10. CRAWLSPACE FOUNDATIONS REQUIRE AN ACCESS MEETING THE REQUIREMENTS OF THE IBC SECTION R408 ACCESS OPENING TO BE 16" x 24". WHEN ACCESS IS LOCATED BELOW GRADE, AN AREAWAY OF 16" x 24" SHALL BE PROVIDED DIRECTLY IN FRONT OF THE ACCESS. AREAWAY SHALL BEGIN BELOW THE LEVEL OF THE CRAWLSPACE ACCESS. ACCESSES SHALL NOT BE LOCATED BEHIND A DOOR OF THE UPPER STORY.
11. FOUNDATION ACCESS SHALL BE DETERMINED, LOCATED, VERIFIED, AND INSTALLED IN FIELD, BY OTHER
12. VERIFY LOCATION, SIZE, AND QUALITY OF EXTERIOR WINDOWS.
13. FOOTINGS WIDTH AND DEPTH - FOOTINGS ARE TO BE CALCULATED BY AN ARCHITECT OR ENGINEER BASED ON HOME DESIGN. TYPICAL SPECIFICATIONS FOR PERIMETER FOOTINGS IS 16" x 8". CENTERLINE FOOTING DIMENSION IS 16" WIDE AND 8" DEEP. THESE DIMENSIONS ARE TYPICAL AND ARE AFFECTED BY SOIL TYPE, SOIL COMPACTION, SPECIAL LOADS, ETC.
14. ADJUSTABLE COLUMN SUPPORTS MAY BE REPLACED WITH CONTINUOUS BEARING WALL (MINIMUM REQUIREMENTS FOR WALL WILL BE DOUBLE 2 x 4 TOP PLATE, SINGLE 2 x 4 BOTTOM PLATE AND DOUBLE 2 x 4 STUDS @ 16" O.C. OR DOUBLE 2 x 6 TOP PLATE, SINGLE 2 x 6 BOTTOM PLATE AND SINGLE 2 x 6 STUDS @ 16" O.C.)
15. FOUNDATION ENGINEER TO PROVIDE LOAD PATH FOR UPLIFT FORCES FROM SHEARWALLS TO FOUNDATION (i.e. HOLDOWNS, STRAPPING, ETC.). SUGGESTED DESIGN LOADS TO BE EQUAL TO CAPACITY OF HOLDOWN. (i.e. SIMPSON LSTHD8RJ = 3115# UPLIFT).
16. THE RIM JOIST ALONG THE MARRIAGE LINE CONSISTS OF 1-1/2" x 11-7/8" LAMINATED BEAMS. PROVIDE SUPPORTS PIERS ALONG THE MARRIAGE LINE 2-3/4" SHORTER THAN PERIMETER SUPPORTS. (NOT APPLICABLE WITH TRUSS FLOOR SYSTEMS)
17. **NOTE: \*\*\*THE POINT LOADS THAT ARE SHOWN ON THIS FOUNDATION DRAWING ARE ESTIMATED VALUES. THESE VALUES COULD CHANGE WHEN THE HOME IS ENGINEERED. THESE ESTIMATED VALUES SHOULD NOT BE USED TO SIZE FOOTINGS. THE COMPLETE FOUNDATION DESIGN IS NOT THE RESPONSIBILITY OF BONNAVILLA HOMES \*\*\***

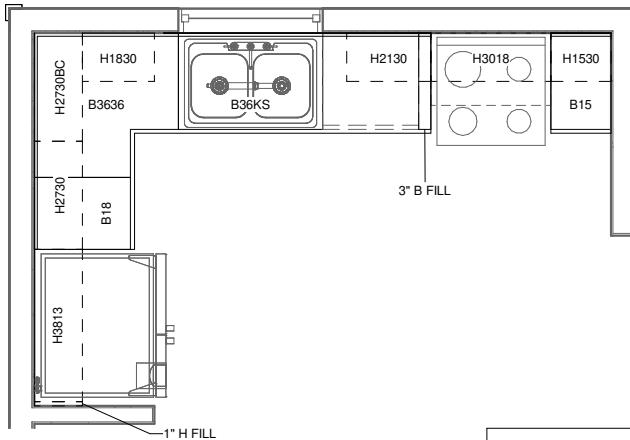


### 1 KITCHEN

15A  
SCALE (22x34): 1/2" = 1'-0"  
SCALE (11x17): 1/4" = 1'-0"


CABINET SCHEDULE - KITCHEN 1									
QTY	CABINET	DOOR			DRAWER			Comments	
		9 3/4"x27	9x27	12x15	12x21	12x27	15x10	15x21	15x27
1	1" H FILL								
1	3" B FILL								
1	B15				1			1	
1	B18						1		1
1	B36KS						2		2
1	B3636	2							
1	H1530					1			
1	H1830							1	
1	H2130		2						
1	H2730					2			
1	H2730BC						1		
1	H3018				2				
1	H3813						2		

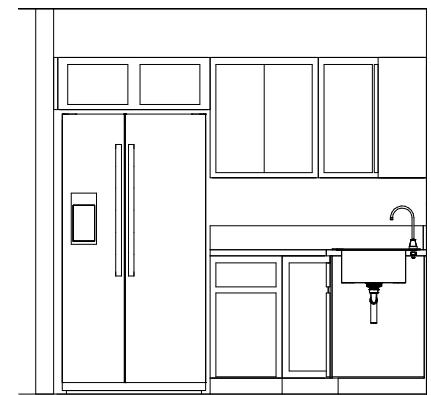

### 1A KITCHEN

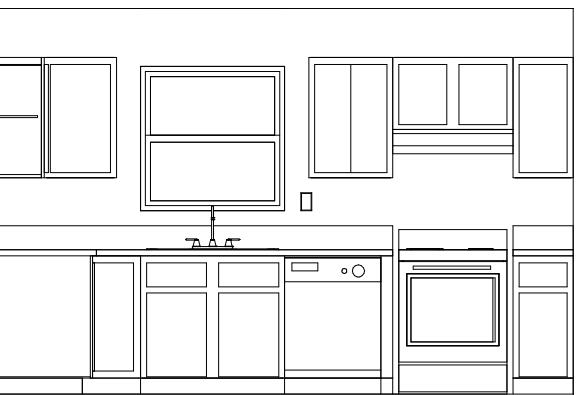


### 1B KITCHEN

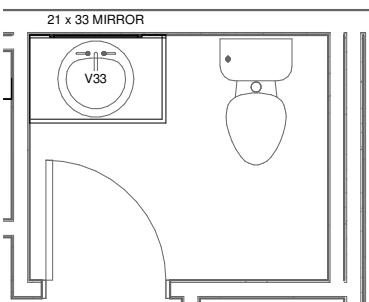

### 2 HALF BATH

15A  
SCALE (22x34): 1/2" = 1'-0"  
SCALE (11x17): 1/4" = 1'-0"


CABINET SCHEDULE - HALF BATH 1			
QTY	CABINET	DOOR	Comments
1	21 x 33 MIRROR	15x21	
1	V33	2	

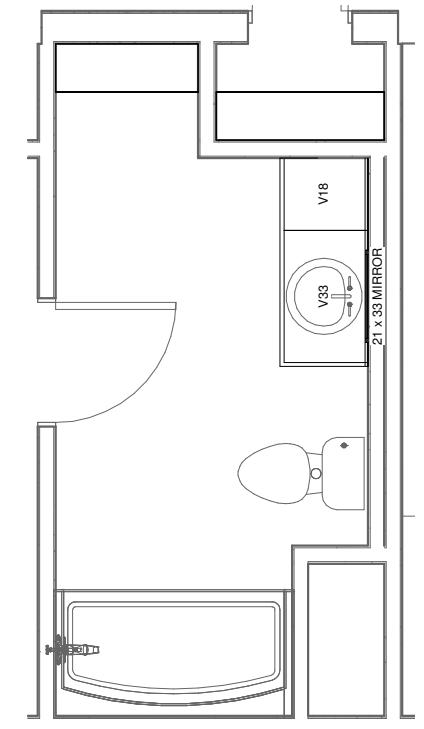

### 3 15A MASTER BATH

SCALE (22x34): 1/2" = 1'-0"  
SCALE (11x17): 1/4" = 1'-0"

CABINET SCHEDULE - MASTER BATH 1			
QTY	CABINET	DOOR	Comments
1	21 x 33 MIRROR	15x21	
1	V18	1	
1	V33	2	

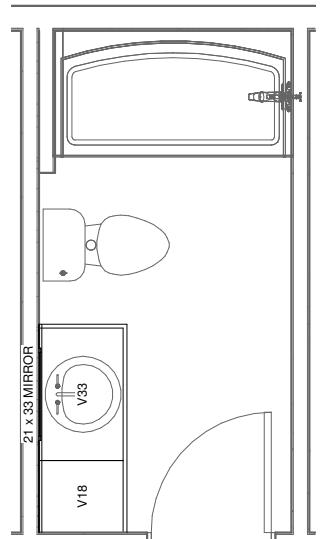

### 4 15A MAIN BATH

SCALE (22x34): 1/2" = 1'-0"  
SCALE (11x17): 1/4" = 1'-0"


CABINET SCHEDULE - MAIN BATH 1			
QTY	CABINET	DOOR	Comments
1	21 x 33 MIRROR	15x21	
1	V18	1	
1	V33	2	

CABINET LIST			
QTY	CABINET	Comments	
2	1" H FILL		
2	3" B FILL		
6	21 x 33 MIRROR		
2	B15		
2	B18		
2	B36KS		
2	B3636		
2	H1530		
2	H1830		
2	H2130		
2	H2730		
2	H2730BC		
2	H3018		
2	H3813		
4	L4SHLF		
4	V18		
6	V33		

**BONNAVILLA**  
A DIVISION OF CIEF INDUSTRIES, INC.  
111 GRANT STREET, AURORA, NEBRASKA 68818

CODE: 2018	IRC	PSF	PSF	
QUOTE NO.	ROOF LOAD:	40	40	
ZONE:	WIND ZONE:			
PID:	DEALER			
DRN. BY: CES	DATE: 02/05/20	DWG No.		


15A

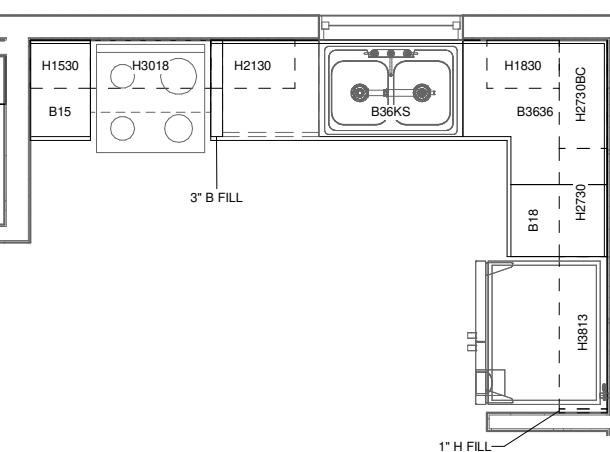


1  
15B KITCHEN

SCALE (22x34): 1/2" = 1'-0"  
SCALE (11x17): 1/4" = 1'-0"


CABINET SCHEDULE - KITCHEN 2										
QTY	CABINET	DOOR				DRAWER				Comments
		9 3/4"x27	9x27	12x15	12x21	12x27	15x10	15x21	15x27	
1	1" H FILL									
1	3" B FILL									
1	B15				1				1	
1	B18						1		1	
1	B36KS						2		2	
1	B3636	2				1				
1	H1530						1			
1	H1830							1		
1	H2130			2						
1	H2730					2				
1	H2730BC					1				
1	H3018				2					
1	H3813						2			

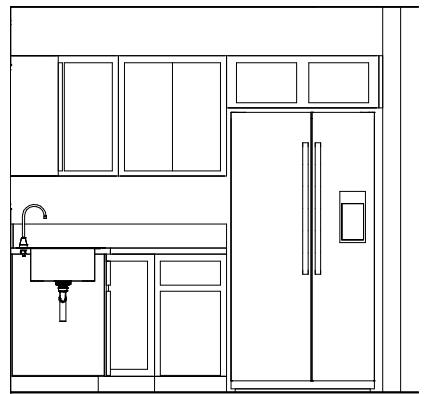

1A KITCHEN

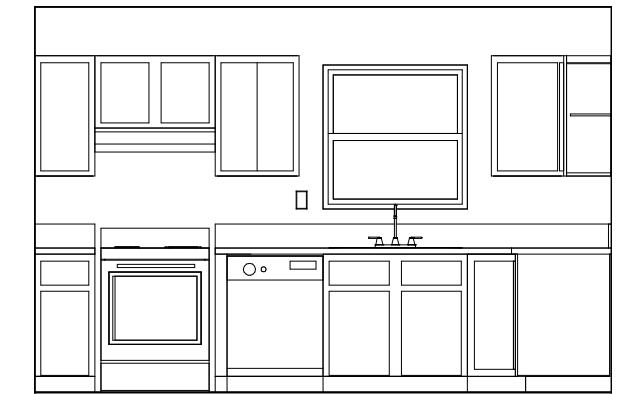


1B KITCHEN

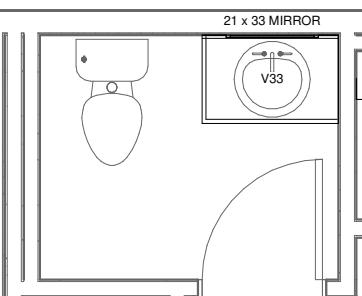


2  
15B HALF BATH

SCALE (22x34): 1/2" = 1'-0"  
SCALE (11x17): 1/4" = 1'-0"

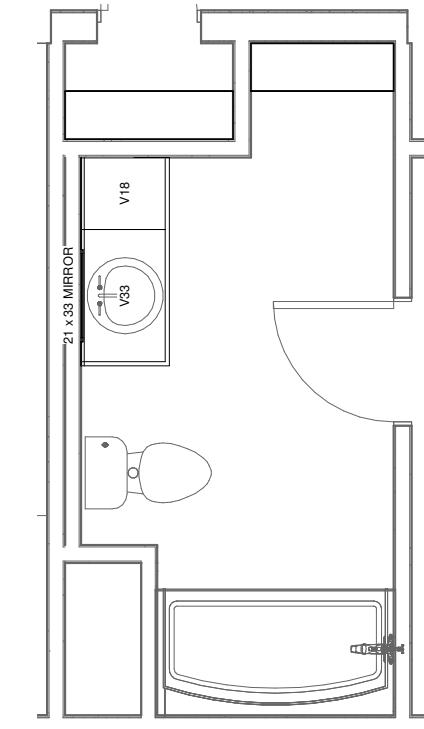

3  
15B MASTER BATH

SCALE (22x34): 1/2" = 1'-0"  
SCALE (11x17): 1/4" = 1'-0"

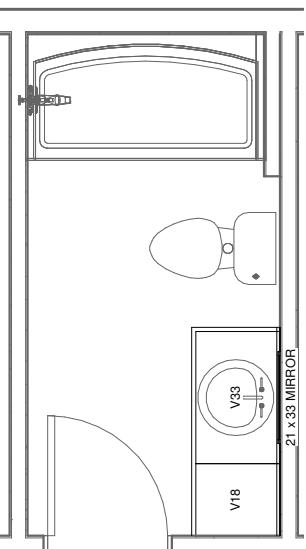

4  
15B MAIN BATH

SCALE (22x34): 1/2" = 1'-0"  
SCALE (11x17): 1/4" = 1'-0"

CABINET SCHEDULE - HALF BATH 2				
QTY	CABINET	DOOR		Comments
		15x21		
1	21 x 33 MIRROR			
1	V33	2		

CABINET SCHEDULE - MASTER BATH 2				
QTY	CABINET	DOOR		Comments
		15x21		
1	21 x 33 MIRROR			
1	V18	1		
1	V33	2		

CABINET SCHEDULE - MAIN BATH 2				
QTY	CABINET	DOOR		Comments
		15x21		
1	21 x 33 MIRROR			
1	V18	1		
1	V33	2		

CABINET LIST		
QTY	CABINET	Comments
2	1" H FILL	
2	3" B FILL	
6	21 x 33 MIRROR	
2	B15	
2	B18	
2	B36KS	
2	B3636	
2	H1530	
2	H1830	
2	H2130	
2	H2730	
2	H2730BC	
2	H3018	
2	H3813	
4	L4SHLF	
4	V18	
6	V33	


**BONNAVILLA**  
A DIVISION OF CIEF INDUSTRIES, INC.  
111 GRANT STREET, AURORA, NEBRASKA 68818

15B  
DWG No.

CODE: 2018	IRC	PSF								
QUOTE NO:										
PID:										
DEALER										
CUSTOMER AMES										
DRAWING TITLE										
CABINET DETAILS - UNIT 2										
GRAND ISLAND, NE										

DRN. BY: CES  
DATE: 02/05/20  
DWG No.

DESCRIPTION  
PRELIMINARY ISSUE  
DRAFT

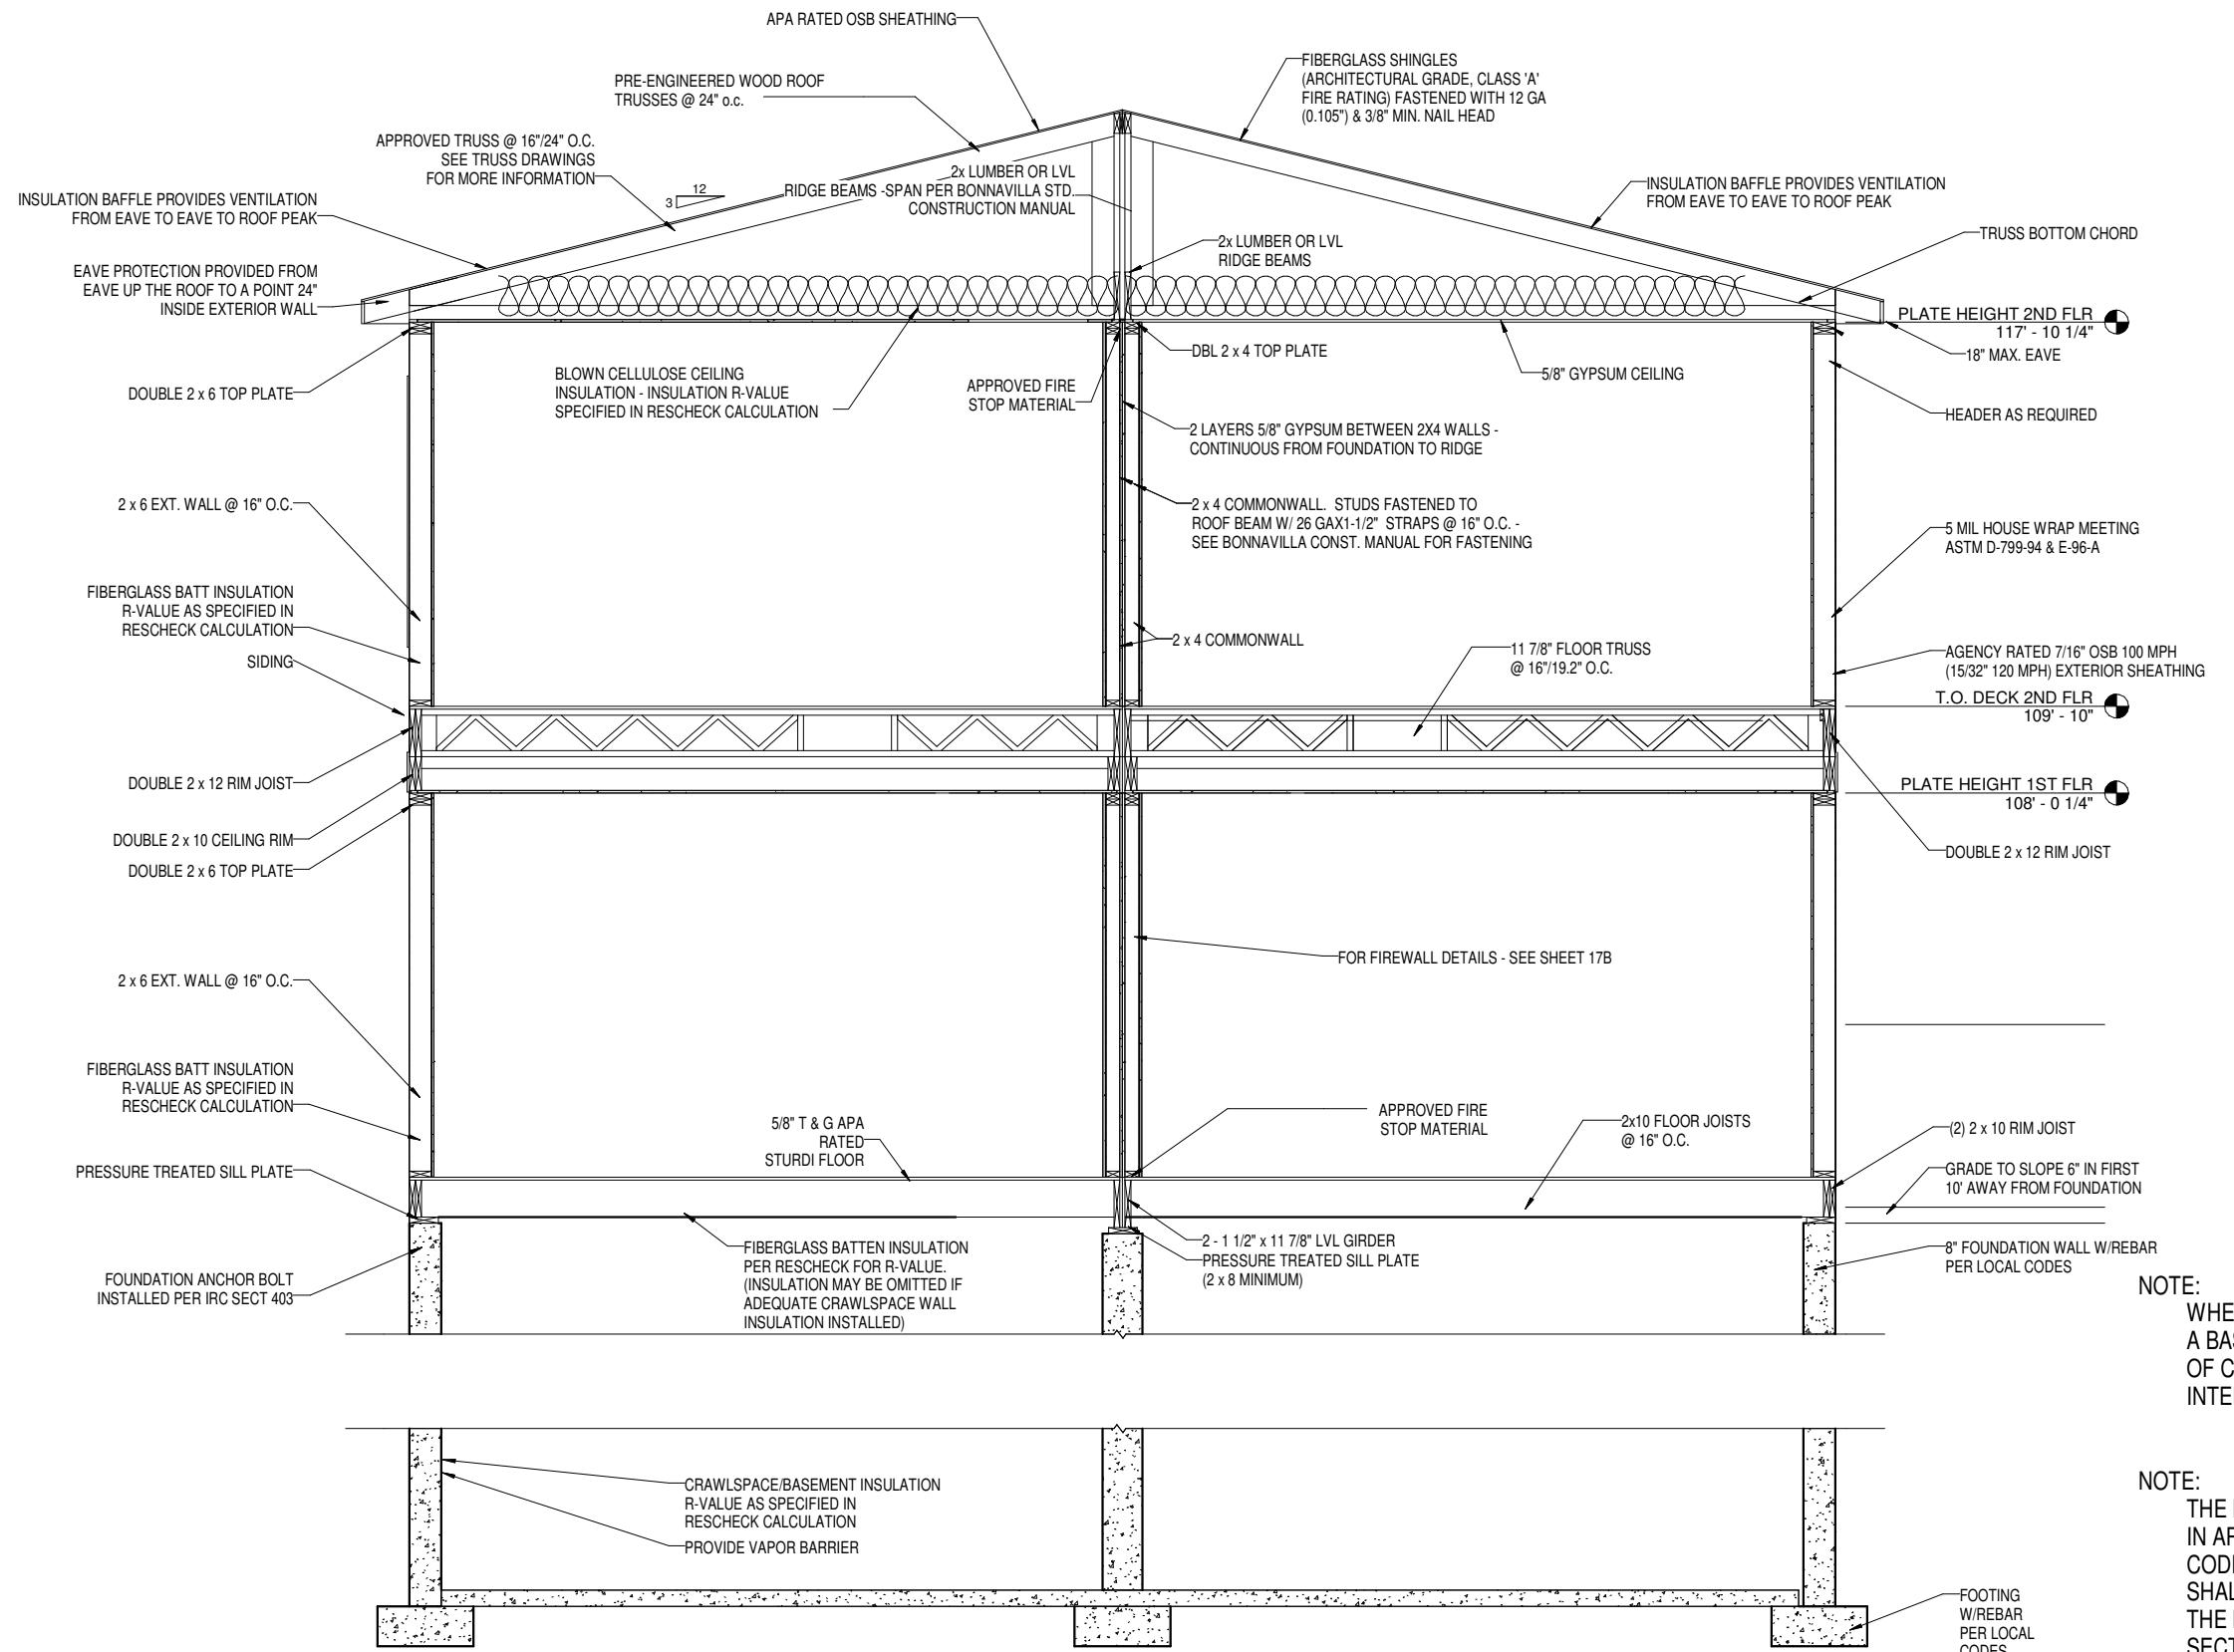

1 BUILDING SECTION

NOTE:  
WHEN A CRAWLSPACE IS USED IN LIEU OF  
A BASEMENT FOUNDATION, CONSTRUCTION  
OF CRAWLSPACE SHALL BE SPECIFIED IN THE  
INTERNATIONAL RESIDENTIAL CODE CHAPTER 4

NOTE:  
THE HOME SHOULD BE GROUNDED AS DEFINED  
IN ARTICLE 250, SECTION III, OF THE NATIONAL ELECTRICAL  
CODE. AS PART OF THOSE REQUIREMENTS, A FOOTING REBAR  
SHALL BE LEFT EXPOSED SO A CONNECTION CAN BE MADE WITH  
THE BUILDING STRUCTURE, AS DEFINED IN NEC ARTICLE 250,  
SECTION III, PART 50.

DESCRIPTION	DINRY	DATE	CES	BANKPACK	PRELIMINARY ISSUE
CODE: 2018IRC					
FLOOR LOAD:	40 PSF				
ROOF LOAD:	40 PSF				
WIND ZONE:					
QUOTE NO.:					
PID:					

CUSTOMER AMES	DEALER
BONNAVILLA	BONNAVILLA

SITE ADDRESS	BUILDING SECTION
GRAND ISLAND, NE	DRAWING TITLE

DRN. BY:	CES
DATE:	02/05/20
DWG No.	